

FIRE RATING
 — 1 HR
 - - - 2 HR

GENERAL NOTES - PLAN
 A. REFERENCE LANDSCAPE DRAWINGS FOR GRADING AND HORIZONTAL CONTROL DRAWINGS.
 B. REF LANDSCAPE DRAWINGS FOR ALL SITE MATERIALS, LAYOUT, AND ACCESS COMPLIANCE SITE PATH OF TRAVEL DRAWINGS.
 C. REFERENCE A-00 FOR ABBREVIATIONS, SYMBOLS AND GENERAL DIMENSIONING NOTES.
 D. REF A-010 FOR ALL WALL TYPE DETAILS AND FIRE-RATED ASSEMBLIES.
 E. REF A-010 FOR TYPICAL METAL STUD FRAMING DETAILS AND GUIDELINES.
 F. REF 0-000 SERIES DRAWINGS FOR CODE SUMMARIES AND EXTENT OF FIRE-RATED CONSTRUCTION.
 G. REF STRUCTURAL DRAWINGS FOR DIMENSIONS AND ELEVATIONS OF STRUCTURAL SLAB AND WALL ELEMENTS.
 H. VERIFY ALL EXISTING CONDITIONS SUCH AS FLOOR ELEVATIONS, WINDOWS, EXISTING STRUCTURE, ETCETERA. NOTIFY ARCHITECT OF ANY DISCREPANCIES BETWEEN ACTUAL CONDITIONS AND INFORMATION ON THESE DRAWINGS.
 I. DIMENSIONS ARE SHOWN AS FOLLOWS UNLESS OTHERWISE NOTED:
 A. EXTERIOR WALLS ARE DIMENSIONED TO OUTSIDE FACE OF BRICK.
 B. INTERIOR WALLS ARE DIMENSIONED TO CENTERLINE OF FRAMING, OR CLEAR DIMENSION.
 C. CONCRETE AND CMU WALLS, SLAB EDGES AND STRUCTURAL STEEL FRAMING ARE DIMENSIONED IN THE STRUCTURAL DRAWINGS.
 D. DOOR AND WINDOW JAMBS ARE DIMENSIONED TO INSIDE FACE OF WALL.
 J. ALL SPOT ELEVATIONS ARE RELATIVE TO LEVEL 1, S.F. 1111 WHICH IS EQUAL TO 454.8' ABOVE SEA LEVEL.

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CONSULTANT

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APPROVALS

REVISION NO. DATE

KEY PLAN (R710)

TRUE NORTH PLAN NORTH

UO LISB LEWIS INTEGRATIVE SCIENCE BUILDING
 UNIVERSITY OF OREGON
 127B UNIVERSITY OF OREGON
 EUGENE, OR 97403-0778

ISSUANCE
 25% CD's

HDR PROJECT NUMBER 108903 THA PROJECT NUMBER 0810

DATE APRIL 23, 2010


SCALE As Indicated

DRAWN BY Author

DRAWING TITLE LEVEL 3 - THIRD FLOOR PLAN

SHEET NUMBER A-103

Ed Van 4/2/10 Edlin 6/9/10 Curran 6/2/2010

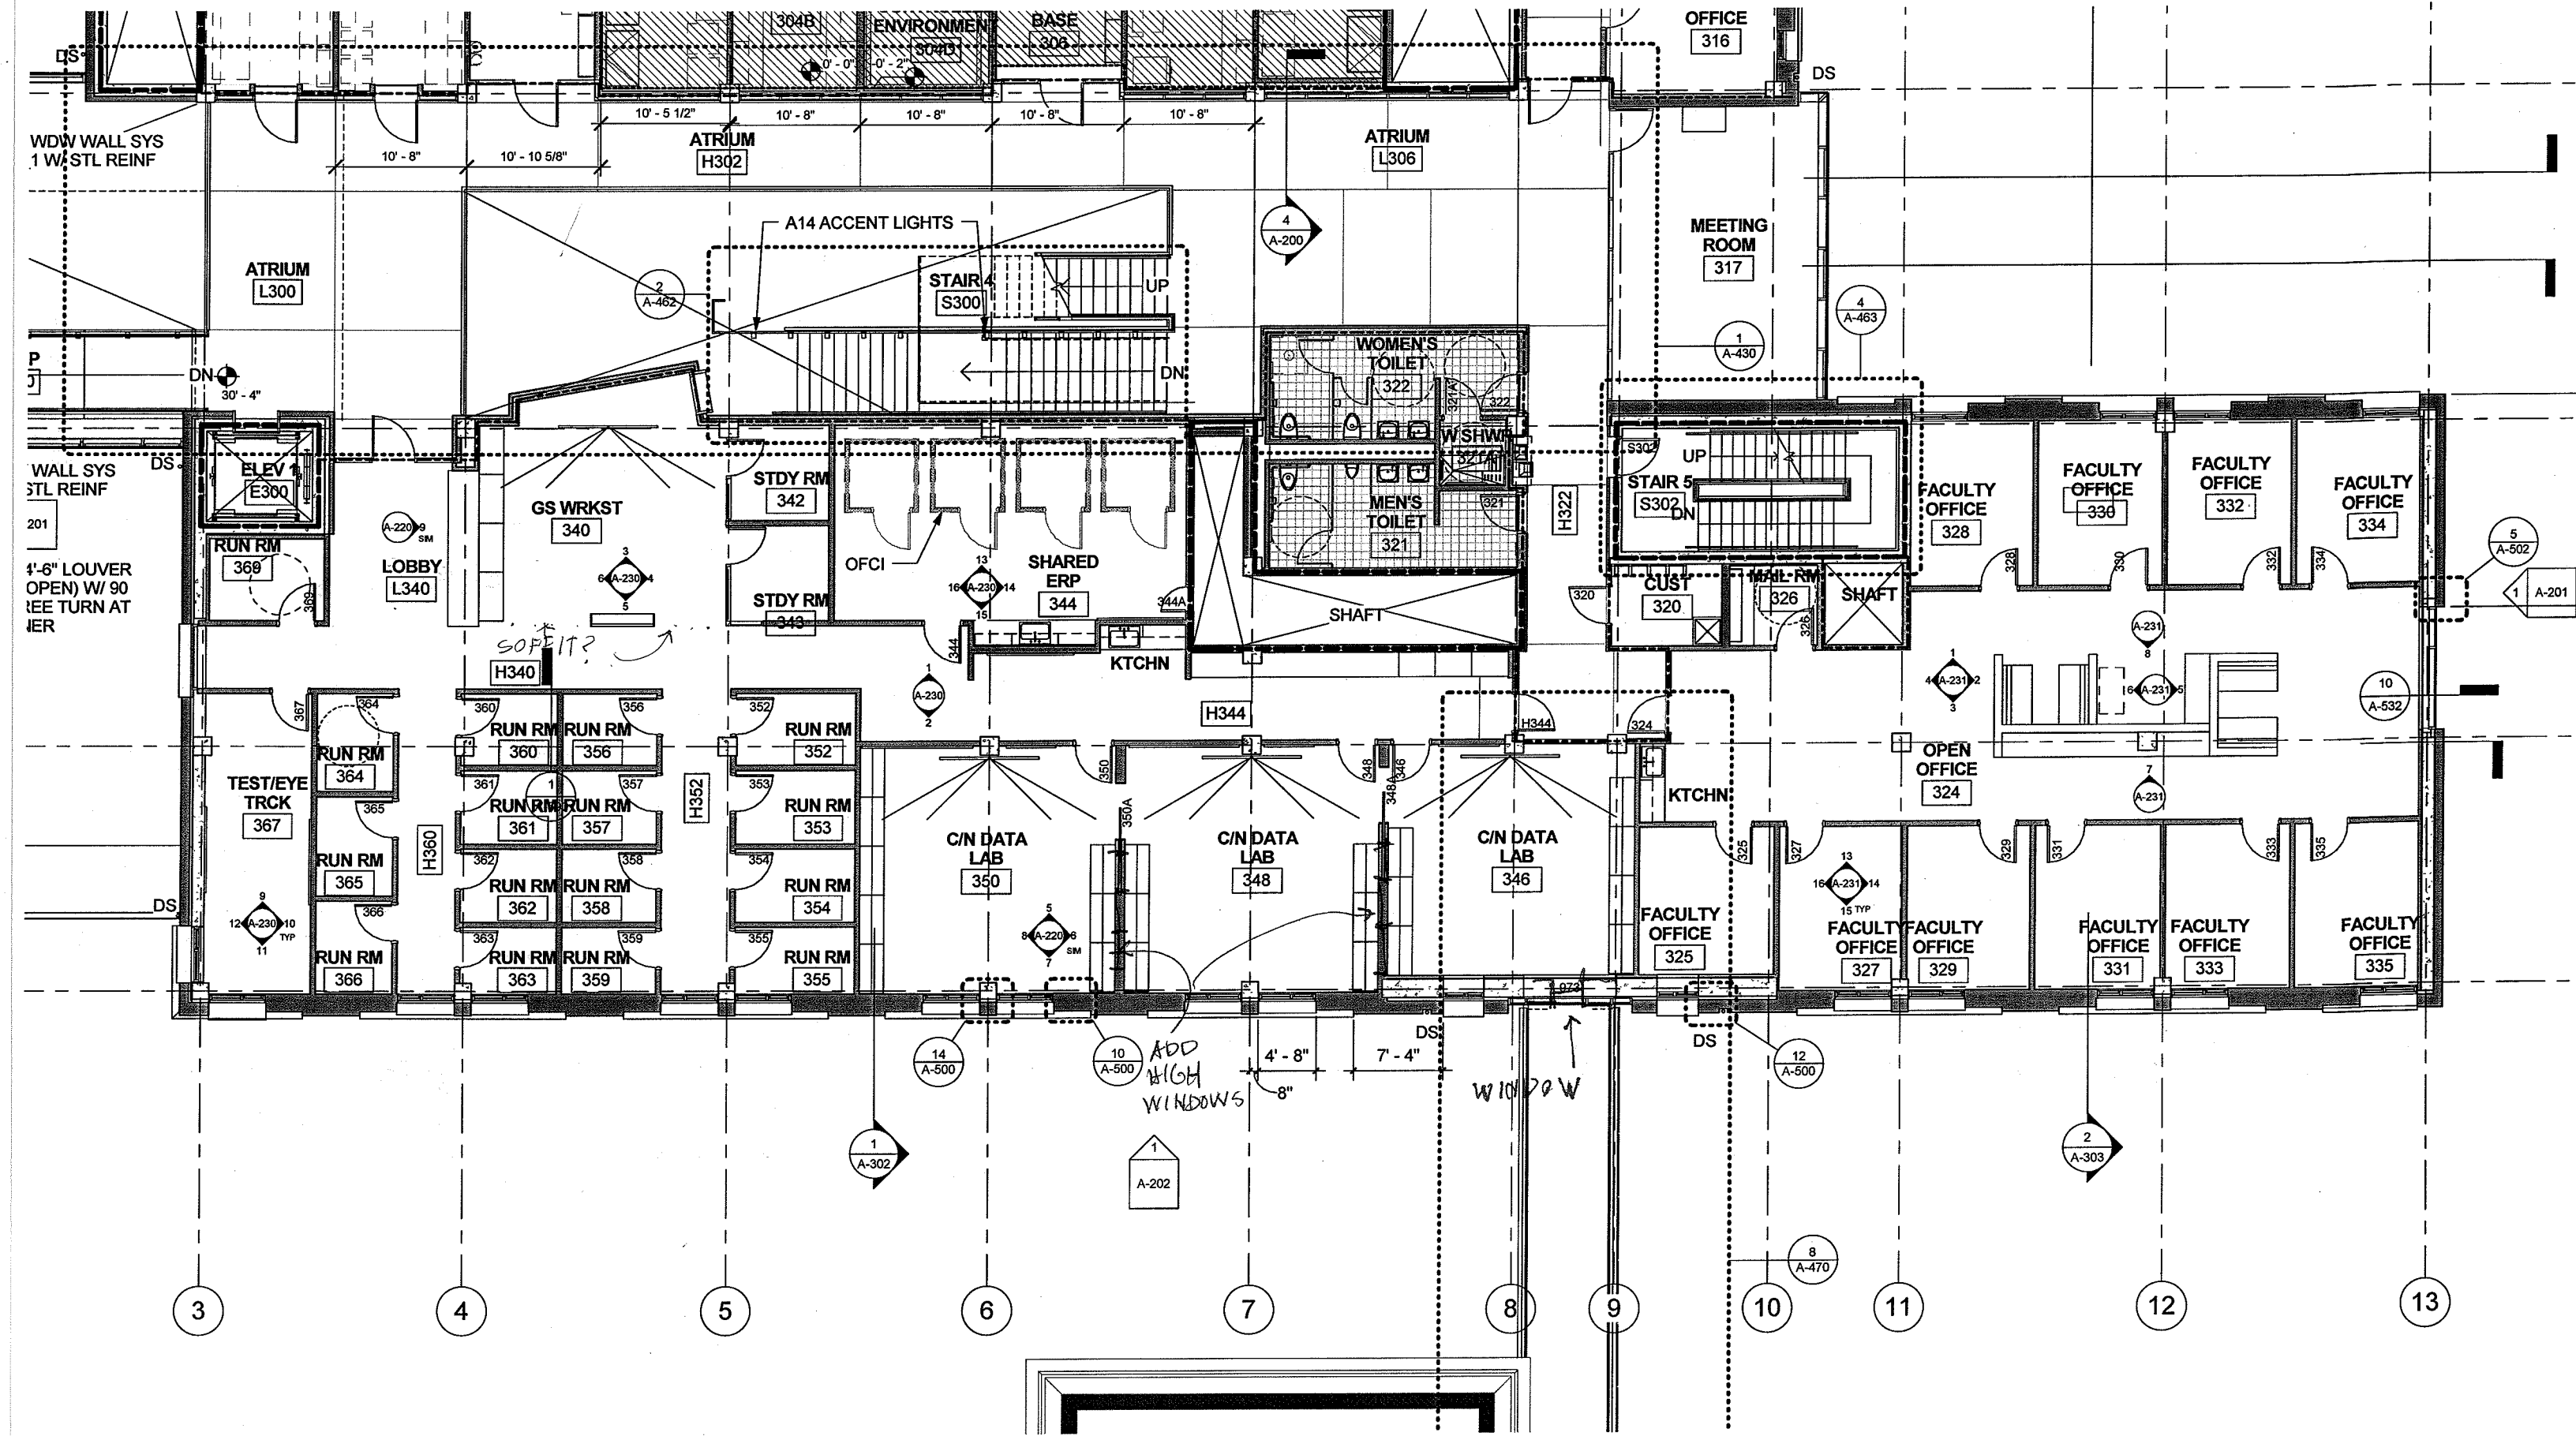

FIRE RATING
 - - - - 1 HR
 - - - - 2 HR


GENERAL NOTES - PLAN

- REFERENCE LANDSCAPE DRAWINGS FOR GRADING AND HORIZONTAL CONTROL DRAWINGS.
- REF LANDSCAPE DRAWINGS FOR ALL SITE MATERIALS, LAYOUT, AND ACCESS COMPLIANCE SITE/PATH OF TRAVEL DRAWINGS.
- REFERENCE A-000 FOR ABBREVIATIONS, SYMBOLS AND GENERAL DIMENSIONING NOTES.
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 - INTERIOR WALLS ARE DIMENSIONED TO CENTERLINE OF FRAMING, OR CLEAR DIMENSION.
 - CONCRETE AND CMU WALLS, SLAB EDGES AND STRUCTURAL STEEL FRAMING ARE DIMENSIONED IN THE STRUCTURAL DRAWINGS.
 - DOOR AND WINDOW JAMBS ARE DIMENSIONED TO INSIDE FACE OF WALL.
- ALL SPOT ELEVATIONS ARE RELATIVE TO LEVEL 1 - 5 ENTER WHICH IS EQUAL TO 434.94' ABOVE SEA LEVEL.

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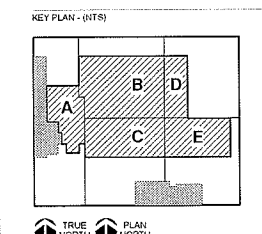


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ISSUANCE
 25% CD's

HDR PROJECT NUMBER 108803 THA PROJECT NUMBER 0810

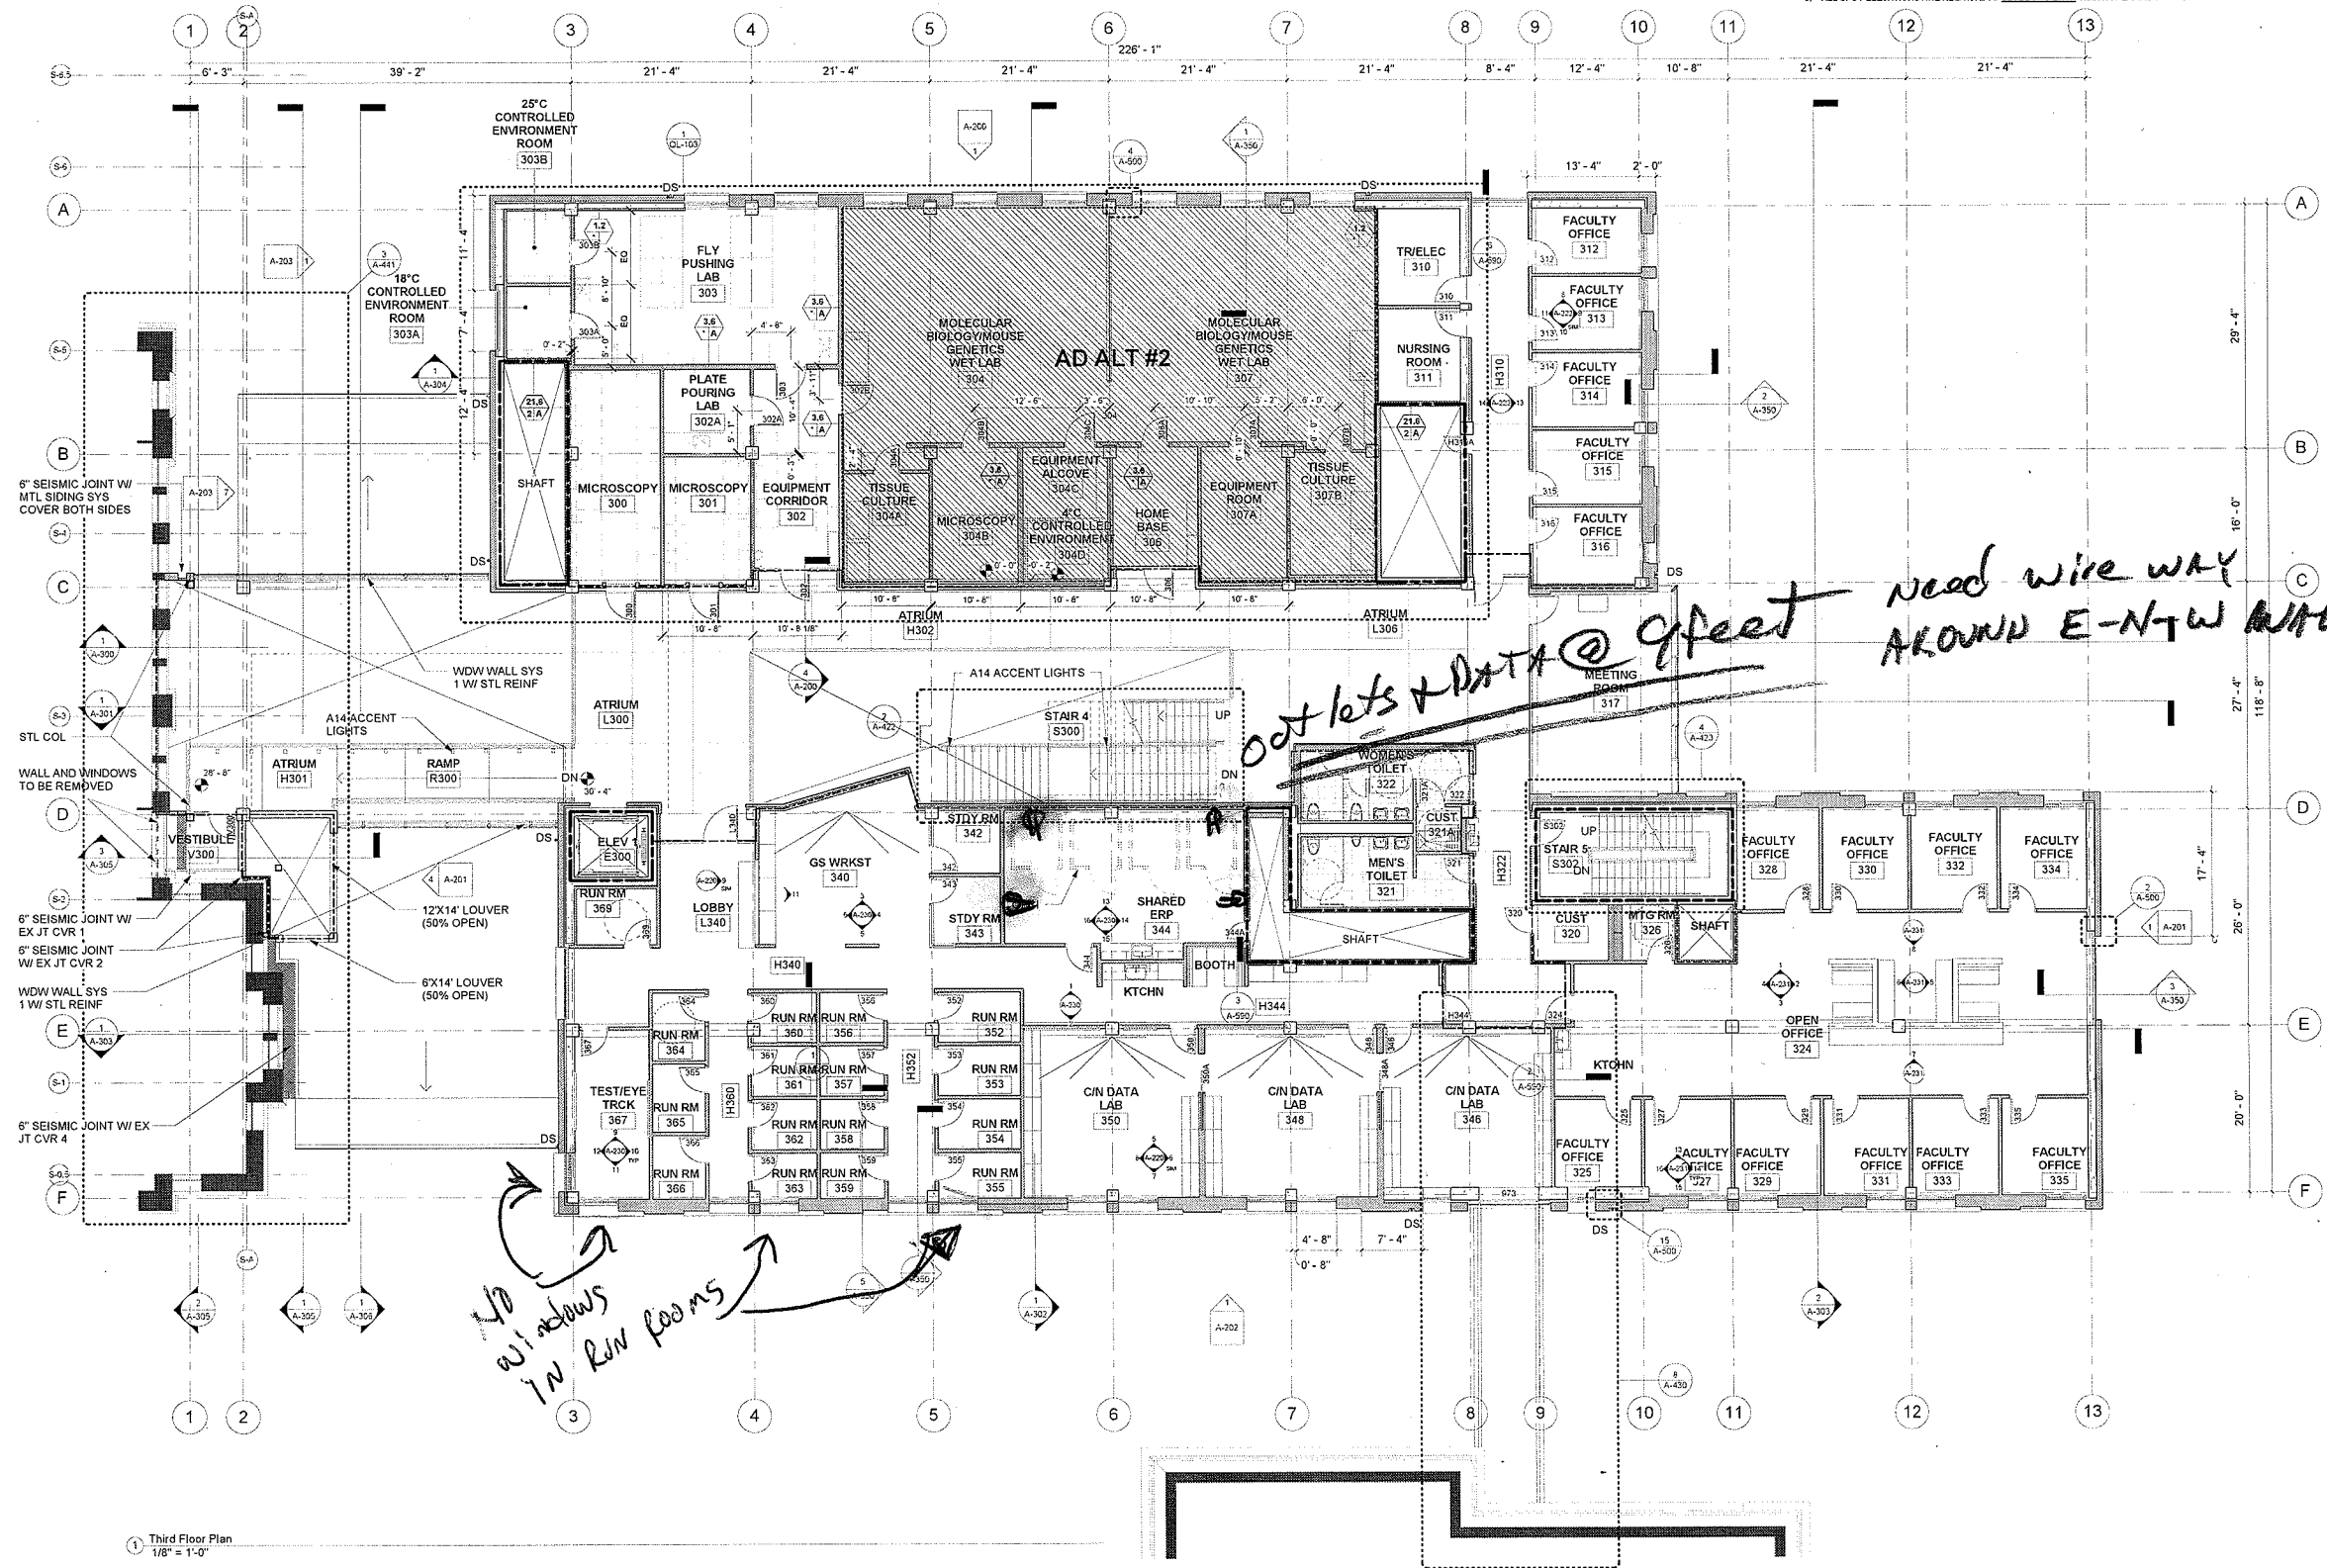DATE APRIL 23, 2010

SCALE As indicated

DRAWN BY Author

DRAWING TITLE
LEVEL 3 - THIRD FLOOR PLAN

1 Third Floor Plan
 1/8" = 1'-0"

CEILING TYPES	CEILING TYPES	LIGHTING TYPES	LIGHTING TYPES	LIGHTING TYPES
ACT-1	PNT CONC STRUC	A1 LINEAR PENDANT DRY LABS	A8A RECESSED LINEAR	A16 UNDER BENCH LIGHT
ACT-2	WD SLAT CLG SYS	A2 LINEAR PENDANT FACULTY OFFICE	A9 DOWNLIGHT	A17 COVE LIGHTING
ACT-3	GBD	A3 LINEAR PENDANT WET LABS	A10 WALL WASHER	A18 COVE LIGHTING
		A5 WALL MOUNT	A11 DIRECTIONAL DOWNLIGHT	A19 IN WALL SLOT LIGHTING
		A6 UNDER SHELF LIGHT 2' LONG	A12 RECESSED LINEAR	A20 DOWNLIGHT SQUARE
		A7 LINEAR PENDANT	A13 DIRECTIONAL DOWNLIGHT SQUARE	A21 WALL WASHER SQUARE
		A7A LINEAR PENDANT	A14 STEPLIGHT	A22 WALL DOWNLIGHT
			A15 DIRECTIONAL STEPLIGHT	

- GENERAL NOTES - REFLECTED CEILING PLAN**
- A. ALL CEILING HEIGHTS ARE FROM FINISH FLOOR ELEVATION UNLESS OTHERWISE NOTED.
 - B. REF G-000 SERIES DRAWINGS FOR CODE SUMMARIES AND EXTENT OF FIRE-RATED CONSTRUCTION.
 - C. SEE MECHANICAL DRAWINGS FOR LOCATIONS OF DIFFUSERS, GRILLES, EXPOSED DUCTWORK AND OTHER MECHANICAL ITEMS IN CEILING.
 - D. DETAIL CUTS INDICATE TYPICAL CONDITIONS UNLESS OTHERWISE NOTED.
 - E. REF ELECTRICAL PLANS FOR LIGHTING FIXTURE TYPES.
 - F. LIGHT FIXTURE TO BE CENTERED IN ROOM OR CEILING BAY UNLESS OTHERWISE NOTED.
 - G. PROVIDE CEILING FRAMING CAPABLE OF SUPPORTING ALL TRIM WORK AND LIGHTING INDICATED.
 - H. STRUCTURAL SUPPORT OF GYPSUM FRAMED CEILING STRUCTURE FROM NON-COMPOSITE METAL DECK IS NOT ALLOWED.
 - I. COORDINATE ALL CEILING FRAMING AND SEISMIC RESTRAINT MEMBERS WITH ALL MECHANICAL PLUMBING, ELECTRICAL, LIGHTING, FIRE-SPRINKLER PIPING, AND OTHER EQUIPMENT. (PRIOR TO INSTALLATION, CONTRACTOR IS REQUIRED TO PROVIDE A COORDINATION CEILING DRAWING SHOWING ALL SUBCONTRACTOR WORK IN AND ABOVE CEILING AREAS. THIS WORK TO SHOW ALL MECHANICAL SYSTEMS (HVAC EQUIPMENT, DUCTWORK, PLUMBING, PIPING, CONTROLS, FIRE PROTECTION SYSTEMS), ELECTRICAL SYSTEMS (LIGHTS, CONTROLS, FIRE AND LIFE SAFETY LIGHTING); STRUCTURAL LIMITATIONS; AND INTEGRATED CEILING HANGERS AND SUPPORTS.)
 - J. VERIFY ALL SPRINKLER HEAD LOCATIONS WITH FIRE PROTECTION DRAWINGS.
 - K. FIRE SPRINKLER HEADS AND OTHER DEVICES ARE SHOWN FOR ARCHITECTURAL INTENT ONLY IN SELECTED ROOMS. DEVICES NOT SHOWN SHOULD NOT BE INTERPRETED THAT THEY ARE NOT REQUIRED. IT IS THE RESPONSIBILITY OF THE CONTRACTOR TO SATISFY THE REQUIREMENTS OF THE LOCAL JURISDICTION FOR QUANTITY AND LOCATION OF ALL DEVICES THROUGHOUT THE PROJECT. OBTAIN APPROVAL OF THE LAYOUT FROM THE ARCHITECT PRIOR TO INSTALLATION OF ALL SYSTEMS AND DEVICES.
 - L. EXPOSED STRUCTURE SERVES AS THE FINISHED CEILING SURFACE IN MANY AREAS. WHEN SERVICES (MECHANICAL, ELECTRICAL, ETC.) ARE EXPOSED CAREFUL COORDINATION IS REQUIRED TO ENSURE THAT LAYOUT IS COMPATIBLE WITH ARCHITECTURAL LAYOUT. THESE PLANS SHOW THE GENERAL INTENT FOR THE FINAL APPEARANCE OF THE LAYOUTS. ADDITIONAL ELEMENTS MAY BE REQUIRED FOR A FULLY FUNCTIONAL SYSTEM AND THESE SHOULD BE INCLUDED USING SIMILAR STRATEGIES FOR LAYOUT AS INDICATED IN THESE PLANS.



1 Third Floor Reflected Ceiling Plan
 1/8" = 1'-0"

2 Run Rooms Reflected Ceiling Plan
 1/8" = 1'-0"


3 Kitchenette & Booth Reflected Ceiling Plan
 1/8" = 1'-0"

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DATE
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SCALE
 As indicated


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DRAWING TITLE
 LEVEL 3 - THIRD FLOOR
 REFLECTED CEILING
 PLAN

SHEET NUMBER
A-153

NEED TRUE EARTH
GROUND FOR Booths.
SAY CENTER ON E+W WALLS?
@ RACE WAY?

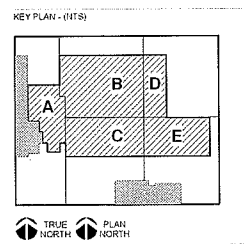we want plugs @ normal ~~left~~ of floor
AND AT 7-8ft off floor

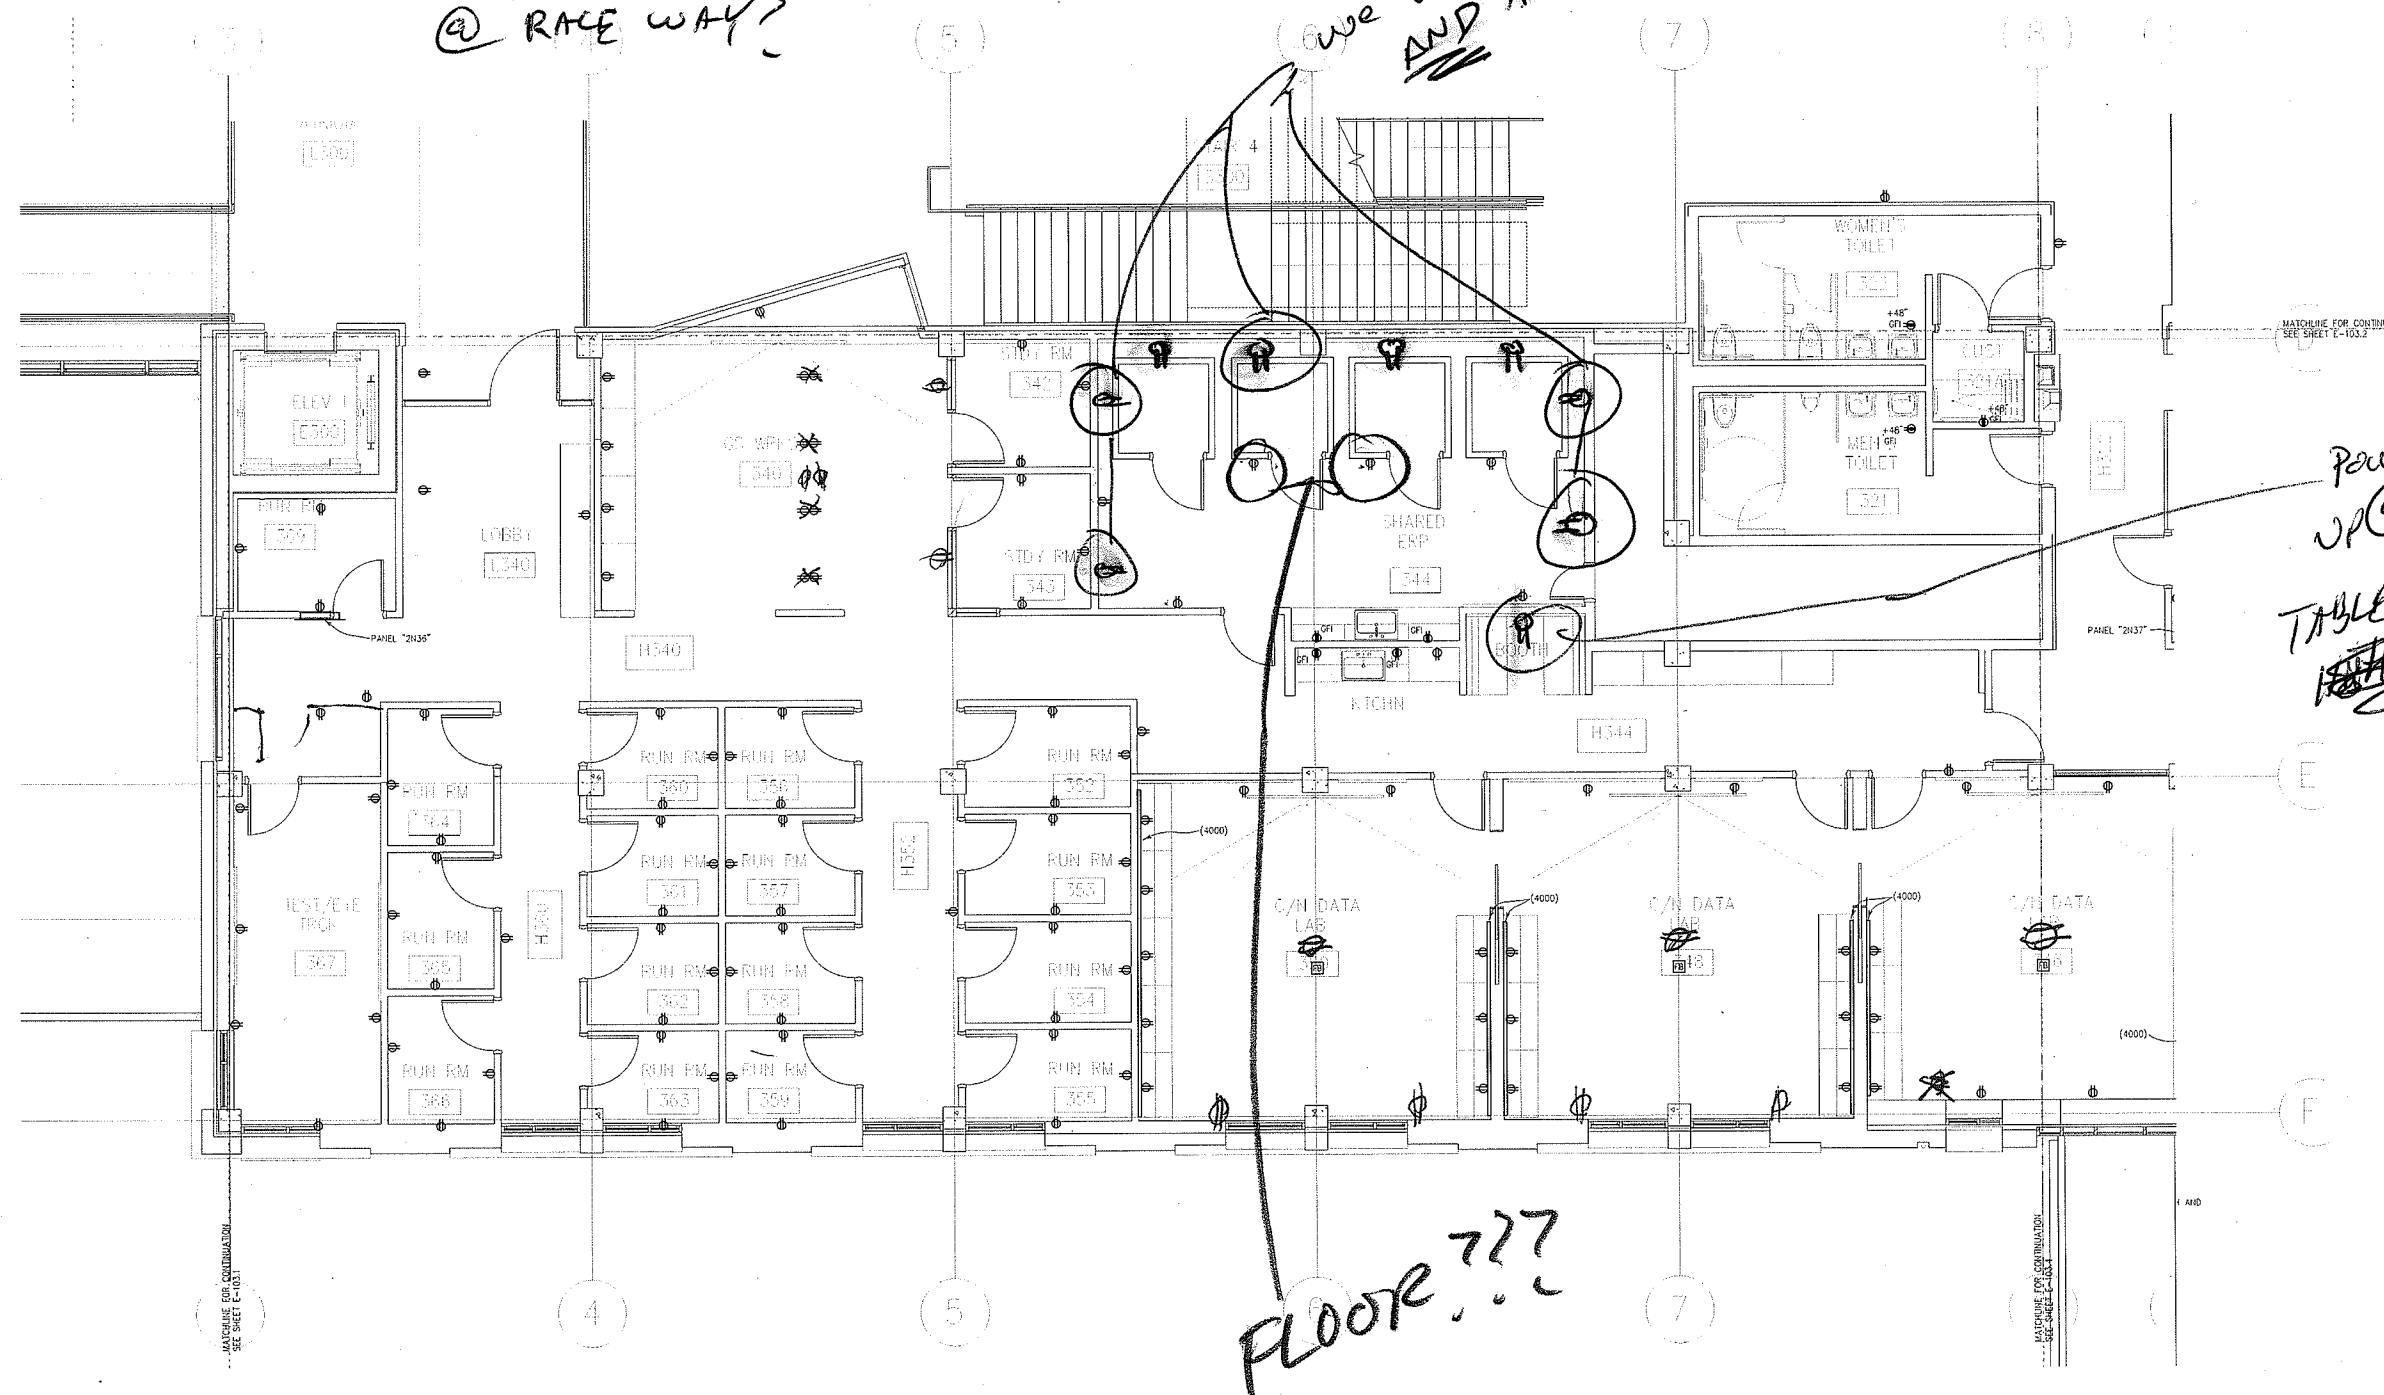

Power
up @
TABLE

FLOOR ???

THIRD FLOOR PLAN AREA "C" - POWER
SCALE: 1/4"=1'-0"

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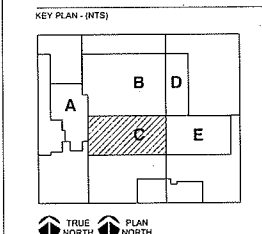
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2100-003-09e103.1234.dwg

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INFORMATION ONLY
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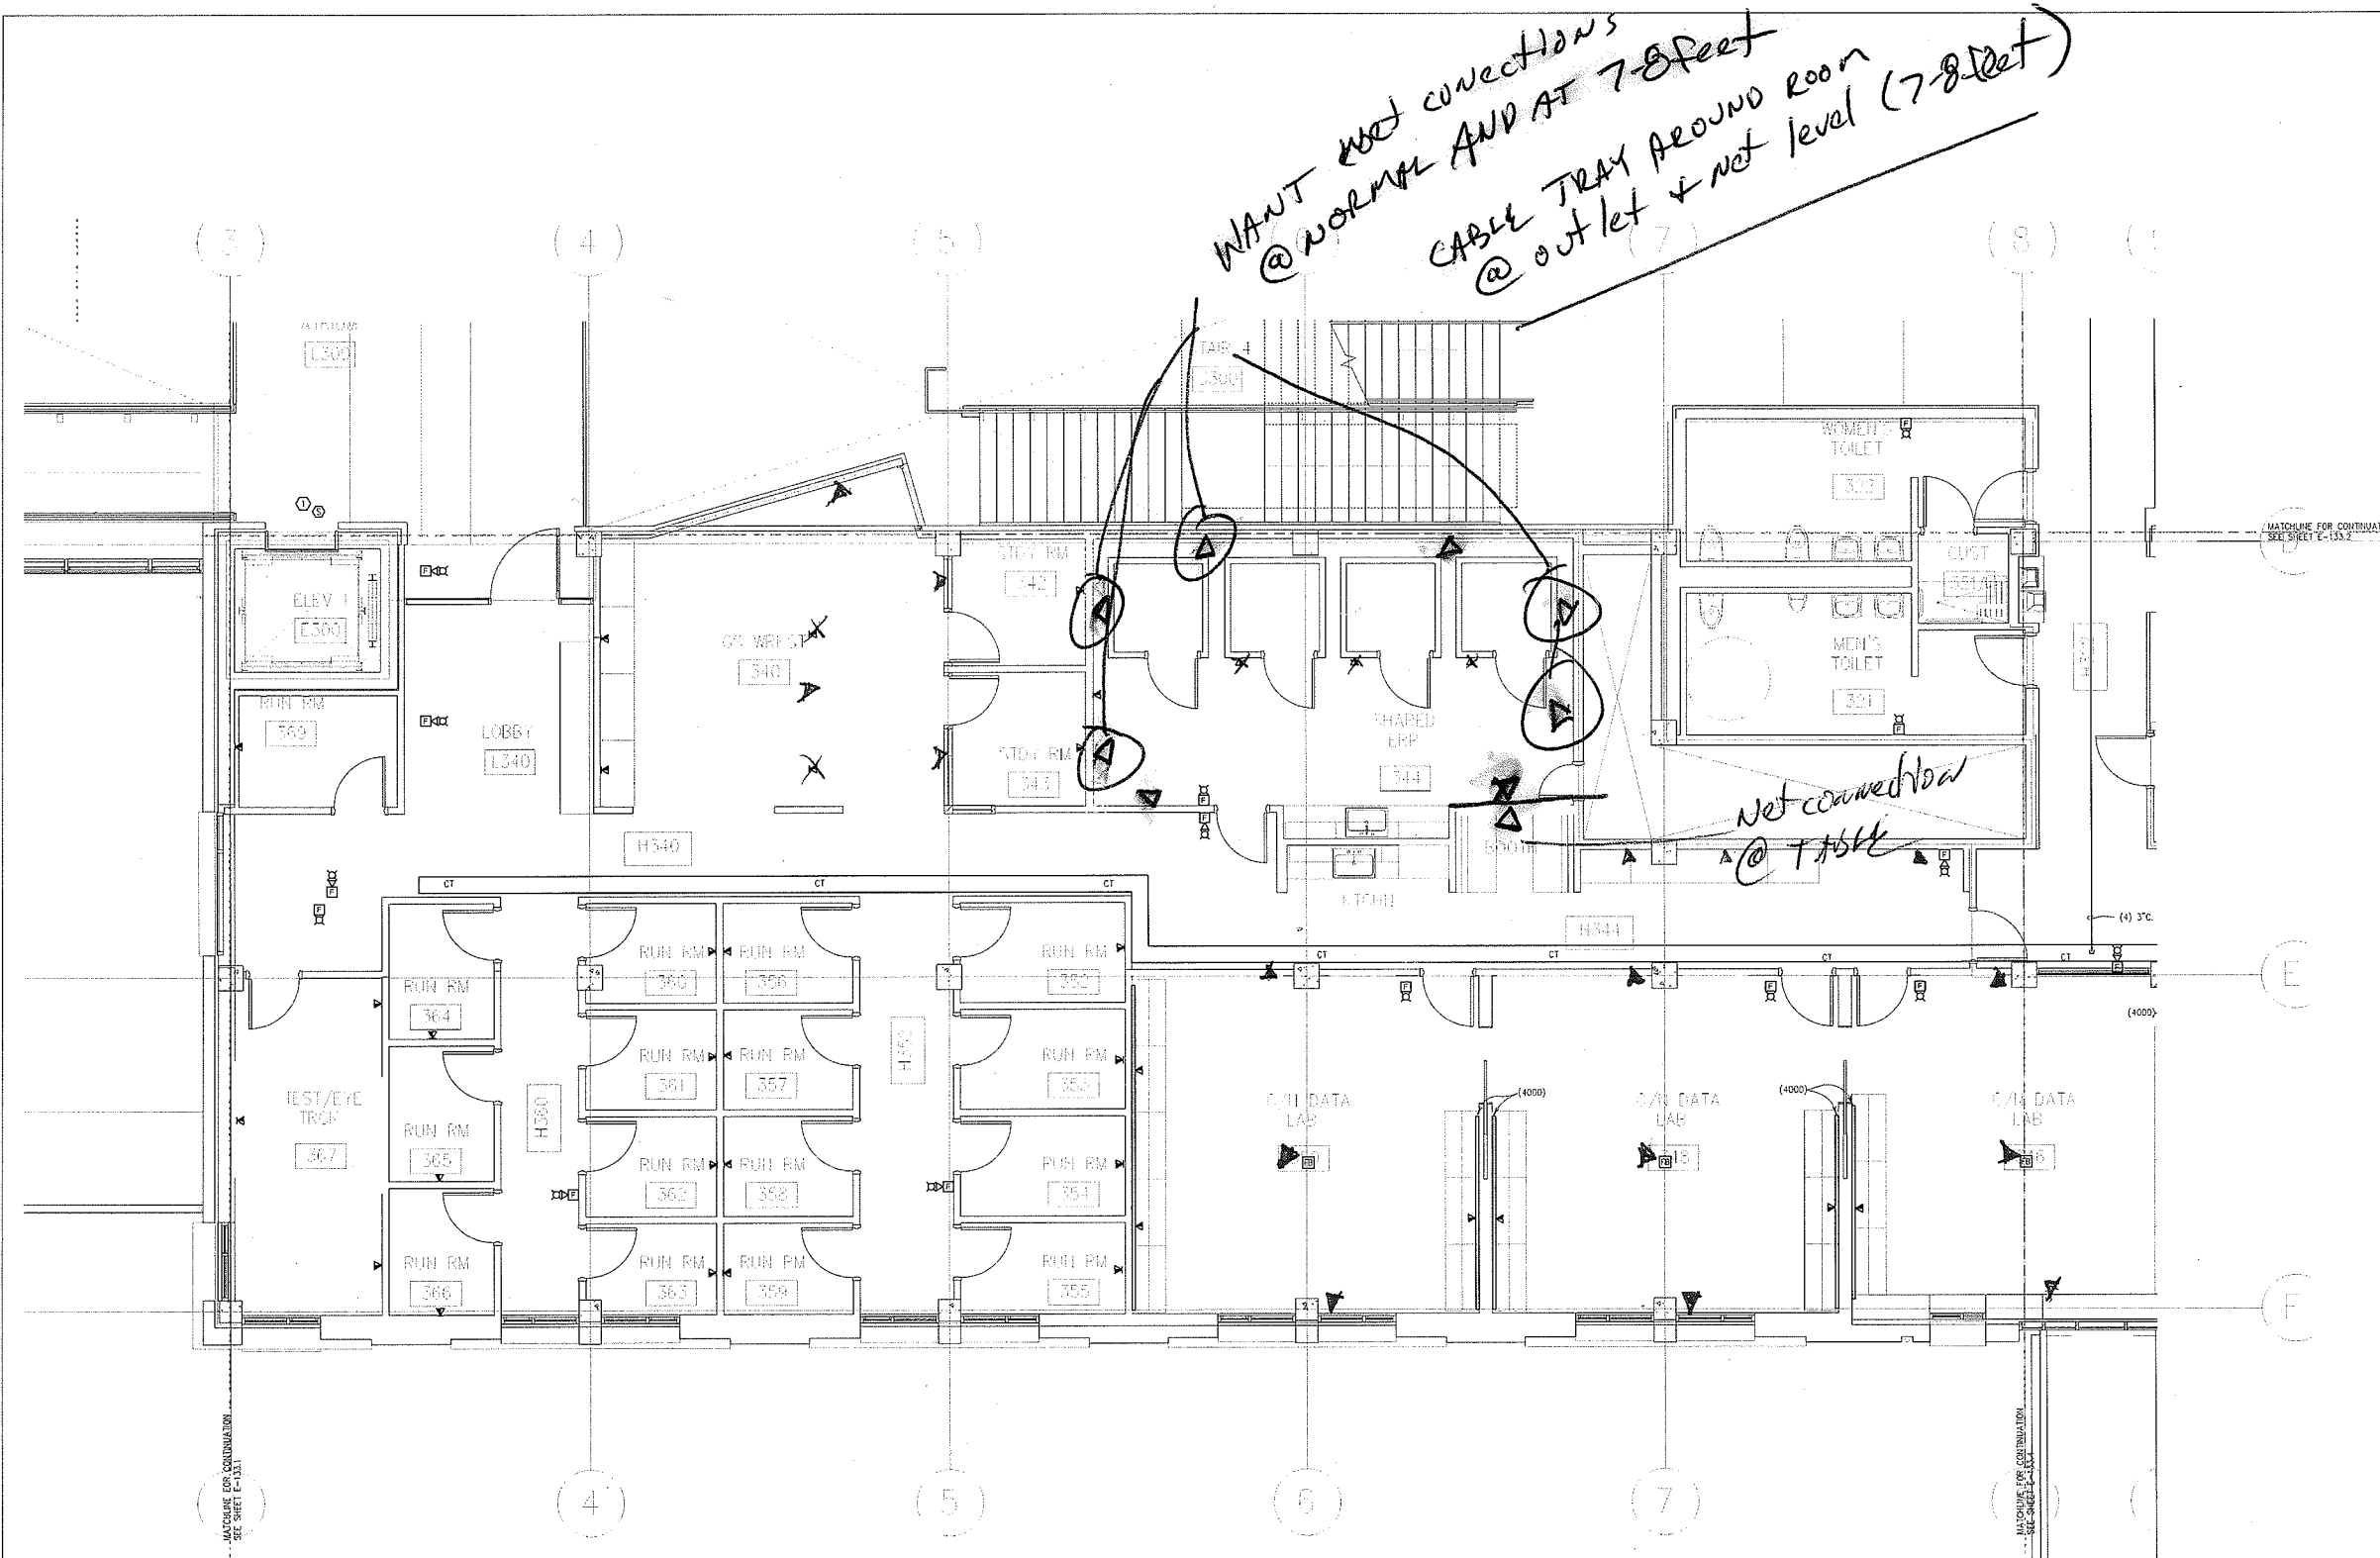
DATE APRIL 23, 2010

SCALE AS NOTED

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DRAWING TITLE
THIRD FLOOR PLAN AREA
"C" - POWER

SHEET NUMBER
E-103.3



THIRD FLOOR PLAN AREA "C" - SIGNAL
SCALE: 1/4"=1'-0"

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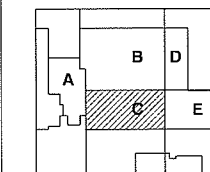
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KEY PLAN - (NTS)



TRUE NORTH PLAN NORTH

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SCALE
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Author

DRAWING TITLE
THIRD FLOOR PLAN AREA
"C" - SIGNAL

SHEET NUMBER

E-133.3

